INDEX OF DRAWINGS

G100 COVER SHEET, GENERAL NOTES, SYMBOLS, &

ARCHITECTURAL DEMOLITION, FLOOR AND REFLECTED

A800 PLAN DETAILS, INTERIOR ELEVATION, DOOR, FRAME, AND

MFP300 MECHANICAL, FIRE PROTECTION AND PLUMBING PLANS

DRAWING INDEX

HARDWARE SCHEDULES

E300 ELECTRICAL PLANS & DETAILS

11. PLEASE SPECIFY, DETAIL AND NOTE THAT ALL ABANDONED AND/OR UNUSED COMPONENTS CREATED OR EXPOSED DURING CONSTRUCTION, INCLUDING — BUT NOT LIMITED TO — HVAC, CABLES, PIPING, WIRING, AND ASSOCIATED

12. PLEASE SPECIFY, DETAIL AND NOTE THAT ALL DAMAGED, DETERIORATED, AND COMPROMISED OR MISSING THERMAL INSULATION - CREATED OR EXPOSED DURING CONSTRUCTION - SHALL BE RESTORED TO FULLY CAPACITY PRIOR TO

EXP

FDN

EXP CONST

FUR CHN'L

GEN CONTR

SUPPORTS AND/OR ATTACHMENTS SHALL BE REMOVED.

FINAL ACCEPTANCE BY THE VILLAGE OF OAK BROOK.

ANCHOR BOLT

ACOUSTICAL CEILING PANEL

ADJACENT OR ADJUSTABLE

ACOUSTICAL CEILING TILE

ABOVE FINISH FLOOR

ABOVE FINISH GRADE

ABRASIVE

ACOUSTIC

ADDITION

ADDITIONAL

ALUMINUM

ANCHOR

ASPHALT

AVERAGE

BASEMENT

BOARD

BETWEEN

BUILDING

BEARING

BRACKET

BRICK

CEILING

CLEAR

CLEAN-OUT

COMBINATION

CONCRETE OPENING

CERAMIC TILE (TYPE)

CABINET UNIT HEATER

CABINET UNIT VENTILATOR

CONCRETE

CONDITION

COUNTER

CENTER(S)

DIMENSION

DOOR OPENING

EXPANSION JOINT

ELECTRIC/ELECTRICAL

ELECTRICAL CONTRACTOR

ELEVATOR OR ELEVATION

ELECTRIC WATER COOLER

DOWN

DOOR

DETAIL

DOWELS

ELEVATION

EMBEDMENT

EMERGENCY

EACH WAY

EPOXY

EQUAL

EACH

DRAWINGS

CONTINUOUS

CONTRACT(OR)

CARPET (TYPE)

COUNTER SINK

CEM PL-(1)

CONC OPNG

CONT

DWGS

DWL'S

ELEC CONTR

EMBED

EMER

EWC

BITUMINOUS

BENCH MARK

BLOCKING (WOOD)

BENT STEEL PLATE

CAST-IN-PLACE

CEMENT PLASTER (TYPE)

CONCRETE MASONRY UNIT

COMPRESSIBLE OR COMPACTED

CERAMIC PAVER TILE (TYPE)

CONSTRUCTION OR CONTRACTION JOINT

BOTTOM OF

AUTOMATIC

ALTERNATE

ACCESS PANEL

APPROXIMATE

COORDINATE PENETRATIONS AND/OR SLEEVES REQUIRED IN WALLS. FLOORS, CEILINGS OR ROOFS FOR MECHANICAL AND ELECTRICAL WORK REQUIRED BY ARCHITECTURAL, MECHANICAL, ELECTRICAL, AND

STANDARD ABBREVIATIONS

EXPANSION

FLOOR DRAIN

FOUNDATION

FOUNDATION

FIRE EXTINGUISHER

FIRE HOSE CABINET

ELECTRIC WATER HEATER

EXPOSED CONSTRUCTION

FIRE EXTINGUISHER CABINET

FIRE RETARDANT TREATED

GENERAL CONTRACTOR

GENERAL CONTRACTOR

GYPSUM WALL BOARD (TYPE)

HEATING/VENTILATING/AIR CONDITIONING

INCLUDE /INCLUDING /INCLUDED

INSULATION/INSULATING/INSULATED

LAMINATE/LAMINATING/LAMINATED

MARKERBOARD (LENGTH IN FEET)

MECHANICAL CONTRACTOR

MOP SERVICE BASIN (SINK)

OVERALL OR OUTSIDE AIR

OUTSIDE FACE OR OPPOSITE FACE

OPPOSITE OR OPPOSITE HAND

POUNDS PER SQUARE FOOT

POUNDS PER SQUARE INCH

THE MATERIALS, ABBREVIATIONS, AND DRAFTING SYMBOLS LEGEND ARE EACH AN ALL INCLUSIVE MASTER LIST USED BY THIS FIRM. THE INCLUSION OF THESE LEGENDS INTO THESE DOCUMENTS DOES NOT IMPLY THAT ALL THE SYMBOLS OR MATERIALS INCLUDED IN THESE LEGENDS ARE INCORPORATED INTO THIS PROJECT. ABBREVIATIONS MAY APPEAR WITH PERIODS OR OTHER PUNCTUATION SEPARATING CHARACTERS ON THE DRAWINGS; THE MEANING REMAINS THE SAME.

PRESSURE TREATED OR PAINT

MINIMUM OR MINUTE(S)

GYPSUM PLASTER (TYPE)

HEAVY DUTY OR HARD

HARD WOOD (TYPE)

HOLLOW METAL

INSIDE DIAMETER

KNOCK DOWN

LIGHTWEIGHT

MATERIAL

MAXIMUM

MSB

MECHANICAL

MOUNT(ED)

NOMINAL

NUMBER

OPENING

ON CENTER

NOT IN CONTRACT

OUTSIDE DIAMETER

NOT TO SCALE

LONG LEG HORIZONTA

LONG LEG VERTICAL

METAL THRESHOLD

B: MISCELLANEOUS AND DEMOLITION NOTES

SEAL WITH UL APPROVED MATERIALS PENETRATIONS OF DUCTWORK, CONDUIT AND PIPES THROUGH FIRE-RATED ASSEMBLIES, TO MAINTAIN THE RATING INTEGRITY OF THOSE ASSEMBLIES. PROVIDE FIRE DAMPERS AS INDICATED ON THE DRAWINGS.

DETAIL NUMBER-

DETAIL NUMBER-

DETAIL NUMBER -

DETAIL NUMBER -

REFERENCE LINE NO.

DRAWING NUMBER — A6.05

NUMBER

DOOR NO. NEW

DOOR NO. EXISTING

NOMINAL THICKNESS -

CONSTRUCTION TYPE ·

SPECIAL CONDITION -

IDENTIFICATION

WINDOW TYPE IDENTIFICATION

TOILET ACCESSORY

IDENTIFICATION

ELEVATION

204

203.1X

7.531

CONCRETE

CONCRETE

BRICK MASONRY IN

MASONRY IN PLAN

(RUNNING BOND)

MASONRY IN PLAN

STONE MASONRY I

RAKED JOINT IN

CTRL./EXP. JOIN1

BRICK MASONRY I

SECTION DETAIL

MASONRY IN

SECTION DETAIL

STONE MASONRY

SECTION DETAIL

STEEL IN SECTION

DISCONTINUOUS

ROUGH WOOD

ROUGH WOOD

IN SECTION

FRAMING/BLOCKING

FINISHED WOOD IN

SECTION DETAIL

RIGID BOARD

INSULATION

INSULATION

BATT INSULATION

GYPSUM BOARD

ACOUSTICAL

BITUMINOUS

CONCRETE

IN SECTION

AGGREGATE

SECTION

UNDISTURBED

EARTH BACKFILL

(ASPHALT) PAVING

BALLAST, FILL OR BACKFILL IN

CEILING PANEL

(ROOFING)

BLOCKING IN

(STACK BOND)

DRAWING NUMBER —

3. SEAL WITH ACOUSTICAL SEALANT PENETRATIONS OF DUCTWORK, CONDUIT AND PIPES THROUGH NON-RATED FLOORS, FULL-HEIGHT WALLS/PARTITIONS, ACOUSTICALLY INSULATED WALLS/PARTITIONS, AND SOUND-RATED WALLS/PARTITIONS, TO MAINTAIN THE ACOUSTICAL INTEGRITY OF THOSE

APPLY APPROPRIATE & COMPATIBLE SEALANT MATERIALS AS REQUIRED TO SEPARATE DISSIMILAR METALS, FILL GAPS IN EXISTING ASSEMBLIES OR WHERE NEW AND EXISTING ASSEMBLIES MEET OR WHERE OTHERWISE REQUIRED BY THE SPECIFICATIONS. BRING ANY UNFORESEEN OR CONFLICTING CONDITIONS TO THE IMMEDIATE ATTENTION OF THE

REPAIR, PATCH, OR REPLACE FINISH MATERIALS OR VISIBLE ASSEMBLIES THAT ARE SOILED, CUT OR DAMAGED IN ANY FASHION DURING THE COURSE OF THE WORK. PERFORM PATCHING SUCH THAT EDGES BLEND INTO CONTIGUOUS SURFACES SMOOTHLY, MATCHING TEXTURE AND COLOR OF ADJACENT

ARCHITECT/ENGINEER BEFORE PROCEEDING WITH THE WORK.

PVMT

PLAM

PLB'G

PLYWD

R OR RAD

RO

SCHED

SPK'R

STD WT

T/MAS

VCT

VERT

VEN PL (1)

PLB'G CONTE

PAVEMENT

PLUMBING

PLYWOOD

RISER

RADIUS

ROOF DRAIN

RIGHT HAND

REQUIRED

SQUARE FOOT

SQUARE INCH

SERVICE SINK

SQUARE

SECTION

SIMILAR

SPACING

SPEAKER

STANDARD

SUSPEND(ED)

SYMMETRICAL

TOP OF BEAM

TOP OF CURB

TOP OF STEEL

TOP OF WALL

TYPICAL

VERTICAL

WITHOUT

WINDOW

WIDE OR WIDTH

WATER PROOF

TOP OF MASONRY

VINYL BASE COVED

VINYL BASE STRAIGHT

WALL CORNER GUARD

WELDED WIRE FABRIC

WALL SERVICE BASIN

VINYL COMPOSITION TILE

VENEER PLASTER (TYPE)

TOP OF

SHEET

SCHEDULE

STAINLESS STEEL

SEALER/HARDENER

SLAB ON GRADE

SPECIFICATION(S)

STANDARD WEIGHT

TONGUE AND GROOVE

TOP OF FOUNDATION

TACKBOARD (LENGTH IN FEET)

(WINDOW) UNIT DIMENSION

UNLESS NOTED OTHERWISE

STRUCTURE OR STRUCTURAL

ROUGH OPENING

PLASTIC LAMINATE(D)

PLUMBING CONTRACTOR

POLYVINYL CHLORIDE

GYPSUM PLASTER (TYPE)

RUBBER FLOORING (TYPE)

REINFORCE/REINFORCING/REINFORCED

PRECAST (CONCRETE) OPENING

PIECE

PLATE

PROJECT OAK BROOK TENNIS CENTER FRONT DESK RENOVATION

1450 FOREST GATE ROAD

ARCHITECT/ **ENGINEER**

41 W BENTON STREET **AURORA, ILLINOIS 60506** TEL (630) 406-1213 FAX (630) 406-9472 www.kluberinc.com

1300 FOREST GATE ROAD OAK BROOK, ILLINOIS 60523

OAK BROOK PARK DISTRICT **OWNER**

OAK BROOK, ILLINOIS 60523

KLUBER ARCHITECTS + ENGINEERS

BIDDING DOCUMENTS

REQUIRED CODE COMPLIANCE INFORMATION

REQUIRED PLAN COVER SHEET INFORMATION FOR REVIEW UNDER 2021 INTERNATIONAL CODES, STATE OF ILLINOIS ACCESSIBILITY CODE, AND THE STATE OF ILLINOIS PLUMBING CODE

CODE REVIEW DATA

GENERAL STATEMENT OF OVERALL PROJECT SCOPE AND INTENT

PROJECT CONSISTS OF INTERIOR ALTERATIONS AND REMODELING TO AN EXISTING TWO-STORY RECREATIONAL BUILDING. BUILDING COMPONENTS AND SYSTEMS MODIFIED OR REPLACED AS PART OF THE WORK OF THIS PROJECT HAVE BEEN BROUGHT UP TO MEET THE REQUIREMENTS OF THE APPLICABLE CURRENT CODES. THE AREAS ALTERED FOR OFFICE USE ARE CLASSIFIED AS GROUP A, B AND M.

A. USE AND OCCUPANCY GROUP(S) CLASSIFICATION: A, B, AND M.

B. TYPE OF CONSTRUCTION: II-B

FULLY SPRINKLERED; ALARMED

SQUARE FOOTAGE OF BUILDING: NOT APPLICABLE; RENOVATED AREAS SQUARE FOOTAGE IS 638.

ALLOWABLE SQUARE FOOTAGE: NOT APPLICABLE; NO CHANGE OF USE.

OCCUPANT LOAD BASED ON INTERNATIONAL BUILDING CODE: NOT APPLICABLE; NO CHANGE OF OCCUPANCY USE

OCCUPANT LOAD BASED ON ILLINOIS PLUMBING CODE: 57


DESIGNED LIVE LOADS: NOT APPLICABLE; THIS IS AN EXISTING BUILDING, TO WHICH NO MODIFICATIONS ARE BEING MADE TO STRUCTURAL COMPONENTS.

F. THE DESIGN PROFESSIONALS IN RESPONSIBLE CHARGE ARE IDENTIFIED IN THE SEALS AND CERTIFICATES AREA, BELOW.

SEALS & CERTIFICATIONS

I HAVE PREPARED, OR CAUSED TO BE PREPARED UNDER MY DIRECT SUPERVISION, THE ATTACHED PLANS AND SPECIFICATIONS AND STATE THAT TO THE BEST OF MY KNOWLEDGE AND BELIEF, AND TO THE EXTENT OF MY CONTRACTUAL OBLIGATION, THEY ARE IN COMPLIANCE WITH IBC 2021 EDITION. THE ENVIRONMENTAL BARRIERS ACT AND THE ILLINOIS ACCESSIBILITY

KLUBER, INC. ILLINOIS PROFESSIONAL DESIGN FIRM LICENSE #184-001284

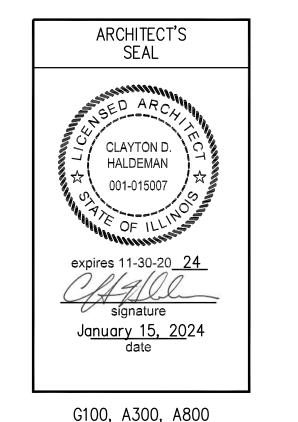

DONALD D. WARE, JR. なく 062-052082 expires 11-30-20 <u>25</u> Yourse O Www. Ja<u>nuary 15, 20</u>24

G100, MFP300

MECHANICAL ENGINEER'S

MICHAEL T KLUBER 062-047325 expires 11-30-20<u>25</u> Wachen Male Ja<u>nuary 15, 20</u>24

ELECTRICAL ENGINEER'S

SEAL

G100, E300

APPLICABLE CODES 2021 INTERNATIONAL BUILDING CODE

2021 INTERNATIONAL MECHANICAL CODE 2021 INTERNATIONAL FUEL GAS CODE 2021 INTERNATIONAL EXISTING BUILDING CODE 2021 INTERNATIONAL FIRE CODE

2020 NATIONAL ELECTRICAL CODE LOCAL AMENDMENTS TO THE ABOVE CODES 2014 ILLINOIS PLUMBING CODE

2021 ILLINOIS ENERGY CONSERVATION CODE (2021 INTERNATIONAL ENERGY CONSERVATION CODE W/STATE AMENDMENTS - EFFECTIVE

2018 ILLINOIS ACCESSIBILITY CODE

JOB NO. 23-310-1501

DRAWN CHECKED APPROVED SHEET TITLE


COVER SHEET, **GENERAL NOTES,** SYMBOLS AND **DRAWING INDEX**

SHEET NUMBER

NOTE: SCALES DEPICTED ON THIS DRAWING ARE NOT CORRECT UNLESS PLOTTED SHEET SIZE IS 30 X 42 INCHES

KEYNOTES ARE TYPICALLY NOT DUPLICATED WITHIN A GIVEN DETAIL.

AN UN-KEYNOTED ITEM IN A DETAIL IS THE SAME AS A KEYNOTED

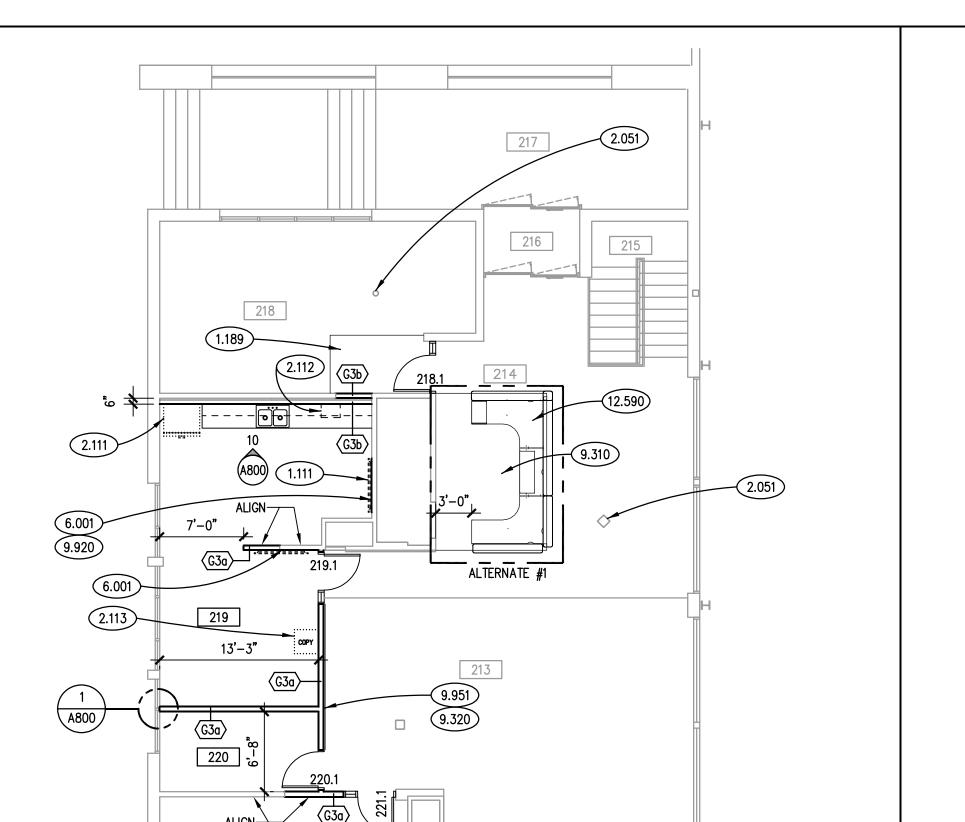

9.930 134 **KEYNOTES**

ITEM HAVING THE SAME APPEARANCE WITHIN THE SAME DETAIL.

1.188 OWNER-FURNISHED ITEM TO BE INSTALLED BY CONTRACTORS: 2' X 2' LAY-IN FIXTURE FROM ATTIC STOCK. 1.189 OWNER-FURNISHED ITEM TO BE INSTALLED BY CONTRACTORS: CARPET TILE FROM ATTIC STOCK.

2.100 EXISTING ARCHITECTURAL SPECIALTY: AS INDICATED.

2.111 EXISTING EQUIPMENT: REFRIGERATOR; TEMPORARILY REMOVE AND RELOCATE. 2.112 EXISTING EQUIPMENT: MICROWAVE; TEMPORARILY REMOVE AND RELOCATE.

2.113 EXISTING EQUIPMENT: COPIER; TEMPORARILY REMOVE AND RELOCATE. 2.131 EXISTING INTERIOR FLOOR FINISH: CARPET.

2.132 EXISTING INTERIOR FLOOR FINISH: QUARRY TILE.

2.133 EXISTING INTERIOR FLOOR FINISH: RESILIENT SHEET/TILE FLOORING. 2.260 EXISTING ELECTRICAL SYSTEM COMPONENT: AS INDICATED.

2.261 EXISTING ELECTRICAL LIGHT FIXTURE: REMOVE DURING CONSTRUCTION AND REINSTALL AFTER NEW CEILING CONSTRUCTION IS COMPLETE.

2.262 EXISTING MECHANICAL DIFFUSER: LINEAR SUPPLY; REMOVE DURING CONSTRUCTION AND REINSTALL AFTER NEW CEILING CONSTRUCTION IS COMPLETE.

2.263 EXISTING REINSTALLED ELECTRICAL LIGHT FIXTURE.

2.452 REMOVE EXISTING INTERIOR WALL CONSTRUCTION: DRYWALL PARTITION.

2.456 REMOVE EXISTING INTERIOR WINDOW: GLAZED ALUMINUM STOREFRONT.

2.457 REMOVE EXISTING INTERIOR SLIDING DOOR: GLAZED ALUMINUM STOREFRONT; FLOOR TRACK.

2.458 REMOVE EXISTING INTERIOR DOOR AND FRAME. 2.467 REMOVE EXISTING INTERIOR CONSTRUCTION: CASEWORK.

2.469 REMOVE EXISTING INTERIOR WALL FINISH: GYPSUM BOARD. 2.470 TEMPORARILY REMOVE AND RE-INSTALL EXISTING INTERIOR WALL FINISH: SLATWALL; REMOVE EXISTING

COVE BASE.

2.471 REMOVE EXISTING INTERIOR WALL FINISH: SLATWALL; REMOVE EXISTING COVE BASE. 2.473 REMOVE EXISTING INTERIOR FLOOR FINISH: AS INDICATED.

2.474 REMOVE EXISTING INTERIOR FLOOR FINISH: CERAMIC TILE; REMOVE EXISTING VINYL BASE.

2.475 REMOVE EXISTING INTERIOR FLOOR FINISH: CARPET/CARPET TILE. 2.476 REMOVE EXISTING INTERIOR FLOOR FINISH: RESILIENT SHEET/TILE FLOORING.

2.478 REMOVE EXISTING QUARRY TILE AREA REQUIRED TO MATCH NEW FURNITURE AT OUTSIDE EDGE OF PARTITION

2.479 REMOVE EXISTING QUARRY TILE: SAW CUT TILE AT LIMITS OF REMOVAL. 2.482 REMOVE EXISTING INTERIOR CEILING FINISH: DRYWALL AND SUSPENDED FURRING.

6.001 ROUGH CARPENTRY: PROVIDE WOOD BLOCKING IN STUD WALL FOR NEW MOUNTED TV MONITOR.

2.498 TEMPORARILY REMOVE EXISTING LIGHT FIXTURE DURING DEMOLITION: REINSTALL IN PLACE.

9.310 LUXURY VINYL TILE: REFER TO SPECIFICATIONS.

9.320 VINYL COVE BASE: MATCH EXISTING; REFER TO SPECIFICATIONS. 9.920 INTERIOR WALL: PATCH AND PAINT GYPSUM BOARD WALL.

9.930 INTERIOR CEILING: PAINT TO MATCH EXISTING. 9.950 DRYWALL SOFFIT: MATCH EXISTING.

9.951 REINSTALL SLAT WALL AND APPLICATION OF COVE BASE.

12.590 SYSTEMS FURNITURE: PROVIDE UNDER SPECIFIED CASH ALLOWANCE AS FOLLOWS: STEELCASE ANSWER SERIES RECEPTION DESK 144" X 42" X 72" CONSISTING OF STEELCASE ANSWER PANELS WITH APPROPRIATE HARDWARE AND JUNCTIONS; ELECTRICAL IN RACEWAY; POWER WHIP; (4) DUPLEX RECEPTACLES; (1) UNIVERSAL BOX/BOX/FILE PEDESTAL 24" DEEP; (1) 42" WIDE UNIVERSAL BOOKCASE; UNIVERSAL WORK SURFACES; CUSTOM/SPECIAL UNIVERSAL TRANSACTION WORK SURFACES; SUPPORTS, CANTILEVERS AND END PANELS AS REQUIRED; GRADE 4 FINISHES.

ROOM SCHEDULE

RM. NO.	ROOM NAME	RM. NO.	ROOM NAME
122	EXISTING CORRIDOR	136	EXISTING MEN'S TOILET ROOM
123	EXISTING CORRIDOR	137	EXISTING WOMEN'S TOILET ROOM
124	EXISTING STAIRS	138	EXISTING WOMEN'S SHOWER
125	EXISTING CORRIDOR	212	EXISTING LOUNGE
126	EXISTING ELECTRIC ROOM	213	EXISTING MERCHANDISE AREA
127	EXISTING WOMEN'S LOCKER ROOM	214	EXISTING LOBBY
128	EXISTING WOMEN'S LOCKER ROOM	215	EXISTING STAIRS
129	EXISTING LOUNGE	216	EXISTING ENTRY VESTIBULE
130	EXISTING WOMEN'S SAUNA	217	EXISTING OUTDOOR COVERED ENTRY
131	EXISTING MEN'S SAUNA	218	OFFICE
132	EXISTING MEN'S LOCKER ROOM	219	OFFICE AND BREAK ROOM
133	EXISTING MEN'S LOCKER ROOM	220	MERCHANDISE CLOSET
134	EXISTING MECHANICAL ROOM	221	EXISTING OFFICE
135	EXISTING MEN'S SHOWER		

GENERAL NOTES

REFER TO DRAWING G100 FOR PROJECT GENERAL NOTES.


REMOVE SALVAGED ITEMS THAT WILL ULTIMATELY BE RE-USED ON THIS PROJECT TO OWNER'S DESIGNATED

PROTECT SALVAGED ITEMS FROM DAMAGE UNTIL INCORPORATED INTO THE WORK OR UNTIL MOVED TO OWNER'S

UNLESS NOTED OR DETAILED OTHERWISE.

9. GYPSUM WALLS ARE WALL TYPE G3a UNLESS TAGGED OTHERWISE.

KEY PLAN

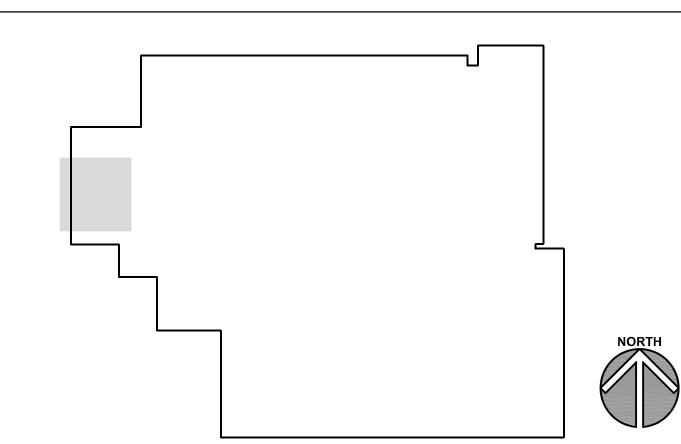

JOB NO. 23-310-1501 SHEET TITLE

ARCHITECTURAL DEMOLITION, FLOOR AND REFLECTED **CEILING PLANS**

NOTE: SCALES DEPICTED ON THIS DRAWING ARE NOT CORRECT UNLESS PLOTTED SHEET SIZE IS 30 X 42 INCHES

B/EXIST. CLG. B/EXIST. CLG. B/EXIST. CLG. B/EXIST. CLG. B/CLG. 9'-4" 9.950 8'-0" B/EXIST. SOFFIT B/EXIST. SOFFIT SLOPED FROM 8'-6" TO 10'-6" UPPER LEVEL REFLECTED CEILING PLAN 6

B/DEMO. CLG.


B/DEMO. CLG.

B/DEMO. CLG.

TYP. B/DEMO. CLG.

212

UPPER LEVEL FLOOR PLAN (4) SCALE: 1/8" = 1'-0"

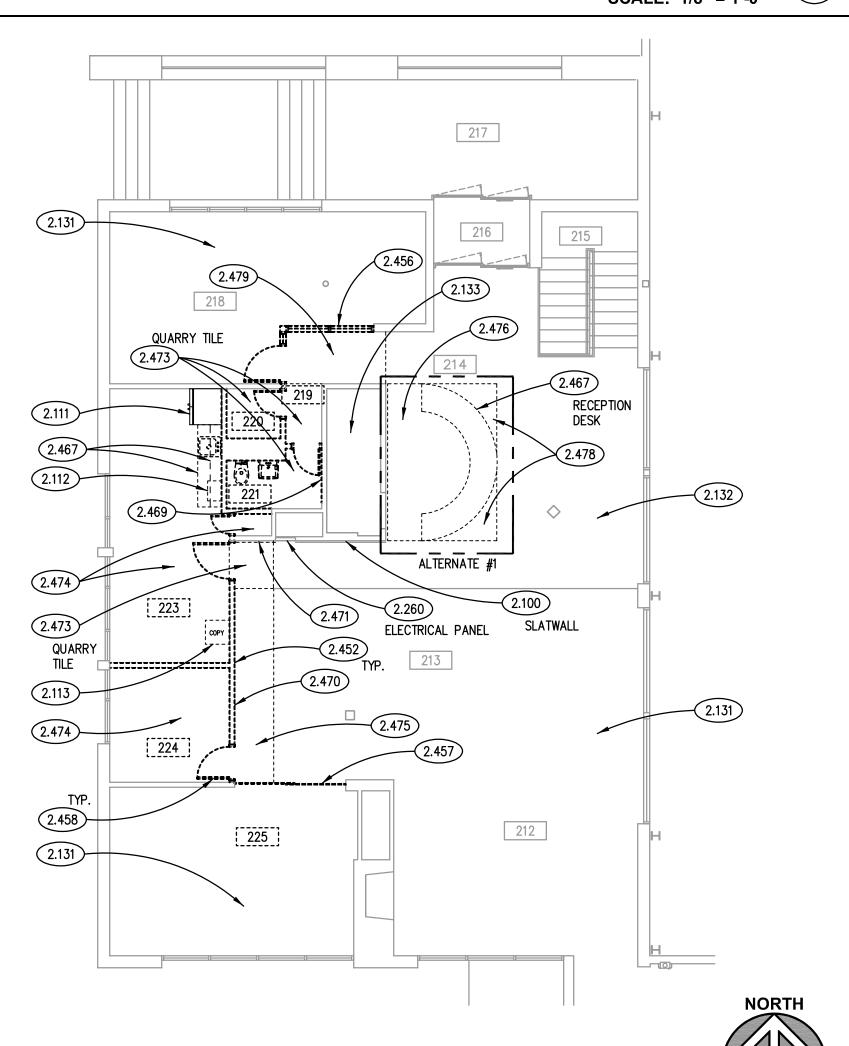

134

LOWER LEVEL REFLECTED CEILING PLAN (2)

SCALE: 1/8" = 1'-0"


LOWER LEVEL REFL. CEILING DEMO. PLAN

SCALE: 1/8" = 1'-0"

UPPER LEVEL REFL. CEILING DEMO. PLAN (5)

UPPER LEVEL DEMOLITION PLAN
SCALE: 1/8" = 1'-0"

3

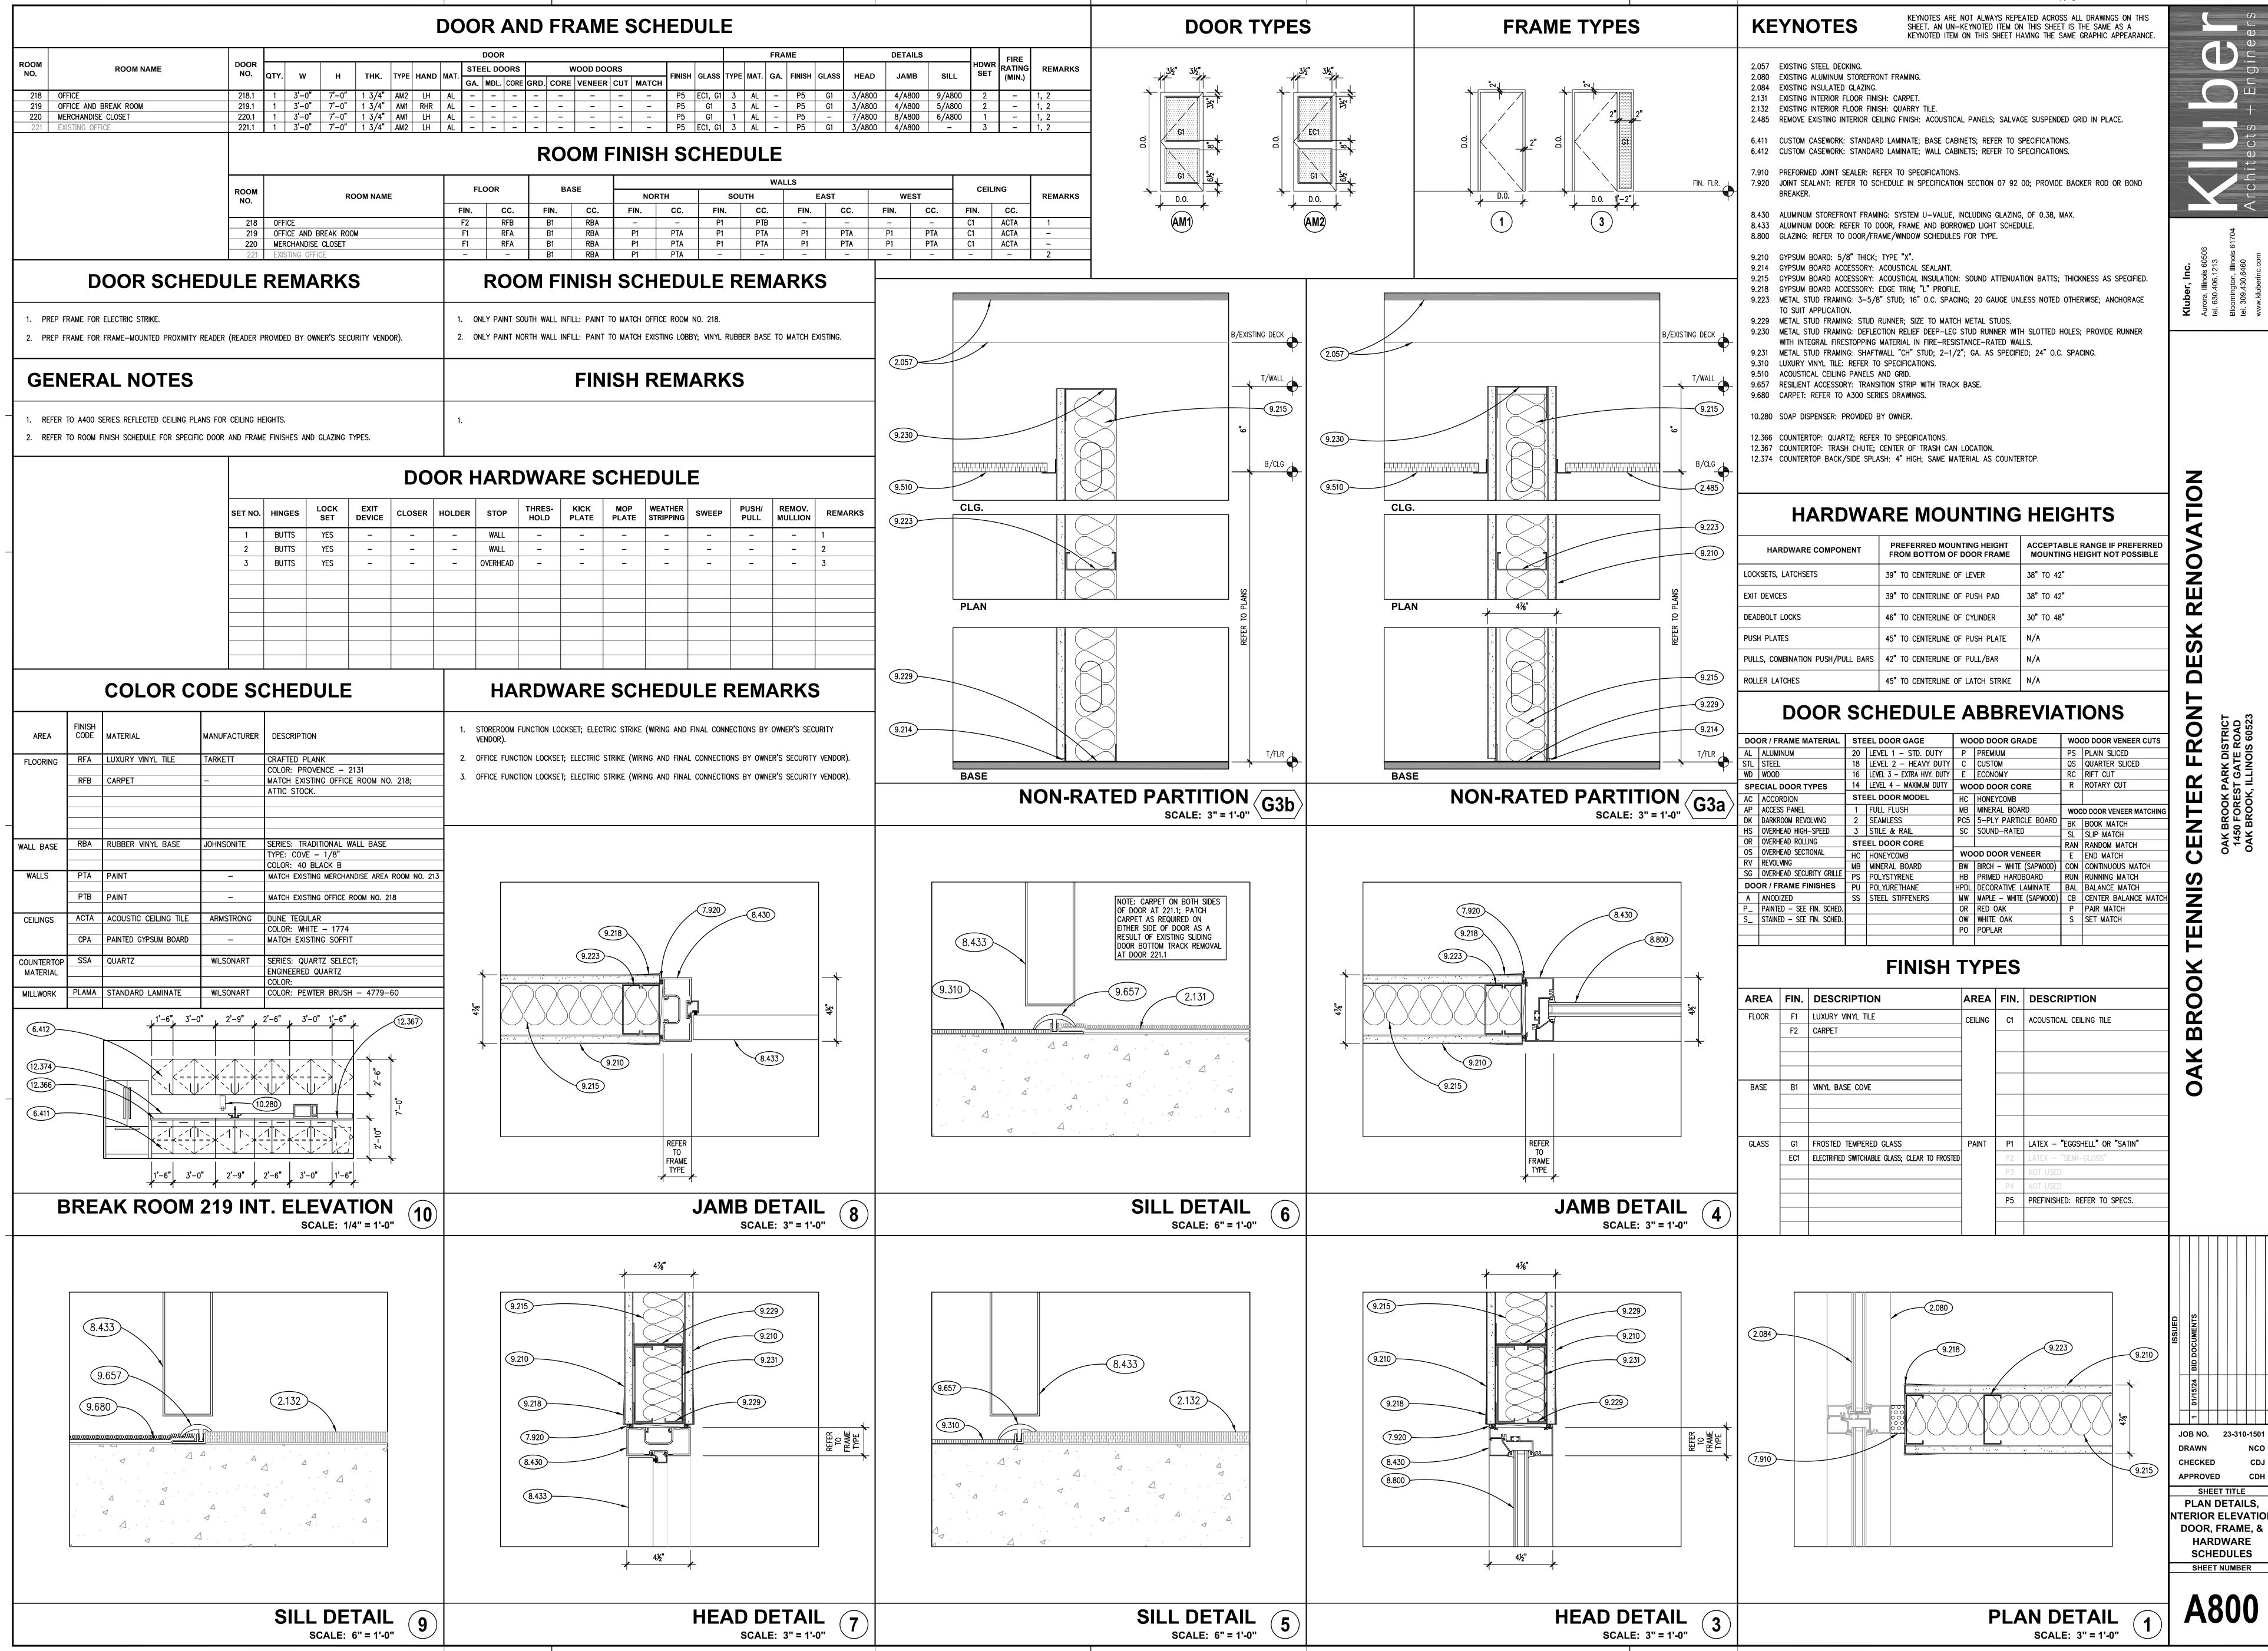

NOTE: SCALES DEPICTED ON THIS DRAWING ARE NOT CORRECT UNLESS PLOTTED SHEET SIZE IS 30 X 42 INCHES

KEYNOTES ARE TYPICALLY NOT DUPLICATED WITHIN A GIVEN DETAIL. AN UN-KEYNOTED ITEM IN A DETAIL IS THE SAME AS A KEYNOTED

ITEM HAVING THE SAME APPEARANCE WITHIN THE SAME DETAIL.

RISER DIAGRAM 5 SCALE: NTS

PLUMBING	FIXTURE	SCHEDULI
I FOMBLIAO		OCHEDUL

TAG	DESCRIPTION	COLD	НОТ	WASTE	VENT	REMARKS
SK	SINK-DOUBLE BOWL	1/2"	1/2"	1-1/2"	1-1/4"	ADAAG COMPLIANT

- . ALL PLUMBING MATERIALS AND INSTALLATIONS SHALL BE IN STRICT ACCORDANCE WITH ALL STATE AND LOCAL PLUMBING RULES AND REGULATIONS CURRENTLY IN EFFECT, GOVERNED BY THE ADMINISTRATIVE AUTHORITY HAVING JURISDICTION.
- 2. THE PLUMBING CONTRACTOR IS RESPONSIBLE FOR THE INSTALLATION OF ALL TRAPS AND CLEANOUTS AS NECESSARY OF THE LOCALITY.
- 3. THE OPENINGS IN WALLS FOR THE PASSAGE OF PIPES SHALL BE TOTALLY FIRE SEALED TO THE SATISFACTION OF THE PLUMBING INSPECTOR AND/OR THE AUTHORITY HAVING JURISDICTION.

KEYNOTES

21.201 MODIFY EXISTING WET PIPE SPRINKLER SYSTEM FOR NEW ROOM CONFIGURATION IN OUTLINED AREA. PROVIDE PERMANENT CAP ON SPRINKLER TAKE OFFS NOT BEING REUSED. PROVIDE ALL MATERIAL AND LABOR TO RELOCATE SPRINKLER HEADS AS REQUIRED FOR PROTECTION. NEW SPRINKLER HEADS SHALL MATCH EXISTING.

22.100 REMOVE ALL WATER, WASTE AND VENT PIPE FROM LOWER LEVEL UP TO FIRST FLOOR PLUMBING FIXTURES BEING REMOVED. PROVIDE TEMPORARY CAP ON PIPES BEING REUSED FOR NEW CONNECTION. FIELD VERIFY

EXACT PIPING CONFIGURATIONS AND LOCATION. 22.101 REMOVE PLUMBING FIXTURE AND ALL ASSOCIATED WATER, WASTE AND VENT PIPING.

22.102 REMOVE SECTION OF VENT STACK UP TO NEAR ROOF LEVEL. VENT THROUGH THE ROOF IS TO BE REUSED.

23.100 REMOVE CEILING EXHAUST FAN AND ALL ASSOCIATED DUCTWORK. CAP ROOF PENETRATION WEATHER-TIGHT. 23.101 REMOVE SLOT DIFFUSER/RETURN GRILLE, STORE AND PROTECT FOR RE-INSTALLATION. PROVIDE TEMPORARY

22.200 PROVIDE 1/2 INCH COLD WATER TO WATER SUPPLY BOX FOR REFRIGERATOR ICE MAKER.

CAP ON DUCTWORK BEING REUSED. 23.102 REMOVE SECTIONS OF DUCTWORK THAT REQUIRES MODIFICATIONS FOR DIFFUSER NEW LOCATION. CAP AND

INSULATE TO MATCH EXISTING. 23.103 REMOVE, STORE AND PROTECT THERMOSTAT FOR VAV-5(e). REFER TO NEW WORK PLAN FOR NEW THERMOSTAT

23.200 COMPLETELY CLEAN AND REINSTALL REMOVED SLOT DIFFUSER/RETURN GRILLE.

23.201 REINSTALL REMOVED THERMOSTAT AND NEW WIRING BETWEEN THERMOSTAT AND VAV BOX. FIELD VERIFY THERMOSTAT COMMUNICATES WITH VAV BOX AND BOX OPERATES ACCORDINGLY.

CEILING SYMBOL LEGEND

SYMBOL	DESCRIPTION	SYMBOL	DESCRIPTION
	GYPSUM BOARD	\boxtimes	MECHANICAL DIFFUSER: SUPPLY
	GTF30INI BOAND	Ø	MECHANICAL DIFFUSER: RETURN
	ACOUSTICAL CEILING TILE: 2' X 2'		MECHANICAL DIFFUSER: EXHAUST
	ACOUSTICAL CEILING TILE. 2 X 2	2'	MECHANICAL DIFFUSER: LINEAR SUPPLY
DOWN LIGHT FIXTURES A: SPOT B: DOWN C: WALL WASHER D: SCONCE			LIGHT FIXTURE: 1' X 4'
A B C D	SPRINKLER HEADS A: UPRIGHT B: PENDANT C: SEMI-RECESSED D: WALL		LIGHT FIXTURES: 2' X 2'

PLUMBING GENERAL NOTES

- REFER TO DRAWING G100 FOR PROJECT GENERAL NOTES.
- ALL SANITARY, WASTE AND STORM PIPES UP TO AND INCLUDING 3 INCHES SHALL SLOPE AT 1/4 INCH PER
- ALL PIPING IS SHOWN DIAGRAMMATICALLY AND DOES NOT SHOW ALL OFFSETS, DROPS AND RISES. THE CONTRACTOR IS RESPONSIBLE TO PROVIDE ALL MATERIAL AND LABOR FOR A COMPLETE AND WORKING SYSTEM.
- OBTAIN AND PAY ALL COSTS FOR PERMITS, LICENSES, CERTIFICATE FILING AND INSPECTIONS BY AUTHORITIES
- EXISTING PIPING INDICATED ON THESE PLANS SHALL BE FIELD VERIFIED FOR EXACT LOCATIONS, QUANTITY AND

REQUIRED FOR ALL PIPING, CONDUITS OR OTHER WORK. CONTRACTOR CUTTING THROUGH OR OTHERWISE DAMAGING RETRO-FIT/REINFORCING DEEMED NECESSARY TO REINSTATE THE CONTINUITY OF THE DISRUPTED ELEMENTS.


- ALL COFFEE MAKERS, HUMIDIFIERS, ICE MACHINES OR SIMILAR EQUIPMENT/FIXTURES WITH A POTABLE WATER SUPPLY LINE SHALL HAVE AN APPROVED DUAL CHECK VALVE DEVICE INSTALLED IN-LINE.

FIRE PROTECTON GENERAL NOTES

- REFER TO DRAWING G100 FOR PROJECT GENERAL NOTES.
- SPRINKLER SYSTEM SHOWN ARE CONCEPT DRAWINGS AND ARE SCHEMATIC FOR BIDDING PURPOSES ONLY. CONCEPT DRAWINGS ARE INTENDED TO ILLUSTRATE THE SCOPE OF WORK. THE CONTRACTOR SHALL VERIFY ALL INFORMATION CONTAINED ON THESE DRAWINGS.
- ALL PIPING IS SHOWN DIAGRAMMATICALLY AND DOES NOT SHOW ALL OFFSETS, DROPS, AND RISES. THE
- THE CONTRACTOR SHALL BE RESPONSIBLE FOR THE DESIGN AND INSTALLATION OF THE SPRINKLER SYSTEM. THE DESIGN SHALL BE ACCOMPLISHED UNDER THE DIRECT SUPERVISION OF A LICENSED PROFESSIONAL ENGINEER OR NICET LEVEL III/IV. SHOP DRAWINGS AND HYDRAULIC CALCULATIONS SHALL BEAR THE LICENSED PROFESSIONAL'S
- 5. FIRE PROTECTION SYSTEM SHALL BE DESIGNED AND INSTALLED IN ACCORDANCE WITH NFPA 13.
- HYDRAULIC CALCULATIONS FOR; LIGHT HAZARD 0.10 GPM/SF OVER 1500 SQUARE FEET; ORDINARY HAZARD GROUP 1, 0.15 GPM/SF OVER 1500 SQUARE FEET; ORDINARY HAZARD - GROUP 2, 0.20 GPM/SF OVER 1500
- SHOP DRAWINGS AND HYDRAULIC CALCULATIONS SHALL REQUIRE SUBMISSION TO KODIAK FIRE PROTECTION SERVICES (OAK LAWN, IL) AND AHJ FOR APPROVAL.
- HYDRANT TEST DATA WAS NOT AVAILABLE. COORDINATE WITH AUTHORITY HAVING JURISDICTION FOR NEW HYDRANT
- 10. ALL SPRINKLER HEADS IN LAY-IIN CEILING TILES SHALL BE CENTERED ON 2'x2' END AREA OF TILE.
- 11. THE CONTRACTOR SHALL COORDINATE HIS WORK WITH ALL TRADES.


12. OBTAIN AND PAY ALL COSTS FOR PERMITS, LICENSES, CERTIFICATE FILING AND INSPECTIONS BY AUTHORITIES

KEY PLAN

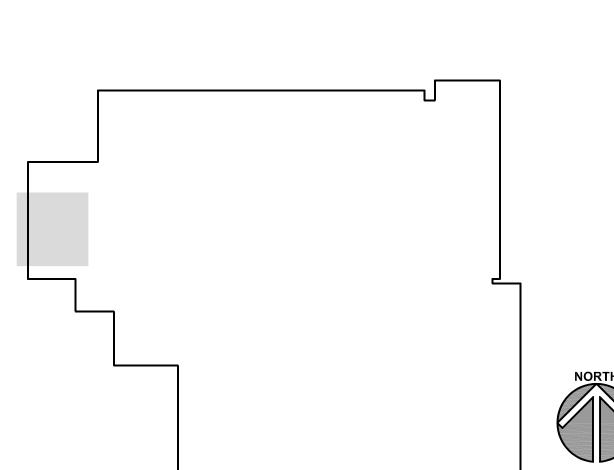


SHEET TITLE **MECHANICAL, FIRE**


PROTECTION AND PLUMBING PLANS

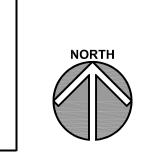

217 B/SOFFIT EXISTING SPRK-(TYP) 9'-4" 11'-0"

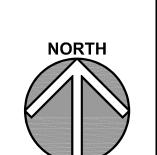

UPPER LEVEL FIRE PROTECTION PLAN
SCALE: 1/8" = 1'-0"

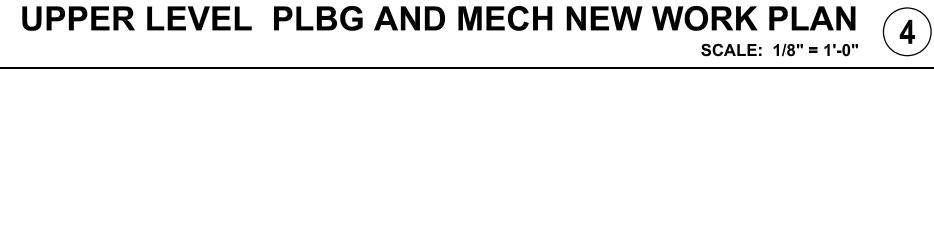

217

123

LOWER LEVEL PLUMBING DEMO & NEW WORK PLAN


NOTE: SCALES DEPICTED ON THIS DRAWING ARE NOT CORRECT UNLESS PLOTTED SHEET SIZE IS 30 X 42 INCHES.

SHEET NUMBER


UPPER LEVEL PLBG AND MECH DEMOLITION PLAN SCALE: 1/8" = 1'-0"

PAN	IEL :	LPA PANEL DEMO				225 AMP MAIN LUG ONLY				
CKT.	BRKR	DESCRIPTION		PHASE			DESCRIPTION	В	BRKR	CKT.
NO.	21444	22001111 11011	Α	В	С					NO.
1	1P20	FRONT DESK LIGHTING				CEIL	ING LITE IN LOU	INGE 1	1P20	2
3	1P20	LITES WASH ROOMS					OFFICE LIGHTS, CHEN LIGHTS +	1 1	1P20	4
5	1P20	MAIN LOBBY LIGHTS				A/V SI	ERVER RECEPT	ACLE 1	1P20	6
7	1P20	ASST. OFFICE RECEP RM. 204 HAND DRYER W.R.				TV	S BY FRONT DE	SK 1	1P20	8
9	1P20	ASST. OFFICE RECEP RM 204					TVS	1	1P20	10
11	1P20	ASST. OFFICE RECEP RM 204					TVS	1	1P20	12
13	1P20	ASST. OFFICE RECEP RM 204					CEILING FANS	1	1P20	14
15	1P20	MICROWAVE					ER FOUNTAIN RE RECEP OUTSIDE	1 1	1P20	16
17	1P20	RECEPT. NURSERY					SPARE	1	1P20	18
19	1P20	RECEPT. MUSIC CALL SYSTEM. UPPER LEVEL CLOCK		CK 1	1P20	20				
21	1P20	COPIER					SPARE	1	1P20	22
23	1P20	RECEPT. LOUNGE AREA					SPARE	1	1P20	24
25	1P20	RECEPT. LOUNGE AREA				RE	ECEPT IN COURT	TS 1	1P20	26
27	1P20	RECPT. CONTROL DESK				CL	OCKS IN COUR	ΓS 1	1P20	28
29	1P20	RECPT. FOR SECURITY				RE	ECEPT IN COURT	TS 1	1P20	30
31	1P20	SIMPLEX UNIT					SPARE	1	1P20	32
33	1P20	COMPUTER REGISTER					SPARE	1	1P20	34
35	1P20	CONTROL DESK PANEL					SPARE	1	1P20	36
37	3P30	SPARE				EXHA	UST FANS IN CO	OURT 3	3P30	38
39	/								/	40
41	/								/	42
		NOTES:			MC	OUNTING:	RECESSED	VOLTAGE	. ,	
	HASE A:					RATING:	EXISTING	VOLTAGE	_ ,	
	HASE B:	0				LOSURE:	NEMA 1		HASE:	
	HASE C:	0				D FROM:	EVICTING	\	WIRE:	
	IAND VA:				FEED	ER SIZE:		\	WIKE:	<u> </u> 4
	D AMPS:	0.00			H		TENNIS SHOP			

CKT. NO. BRKR DESCRIPTION PHASE DESCRIPTION 1 1P20 FRONT DESK LIGHTING CEILING LITE IN LOUNGE 3 1P20 NEW COMPUTER DESKS, ROOM 219 ASST. OFFICE LIGHTS, REC 204, KITCHEN LIGHTS + REC 204, KITCHEN LIGHTS RE	BRKR 1P20	CKT NO.
1 1P20 FRONT DESK LIGHTING CEILING LITE IN LOUNGE 3 1P20 NEW COMPUTER DESKS, ROOM 219 ASST. OFFICE LIGHTS, REC 204, KITCHEN LIGHTS + REC 204, KITCHEN LIGHTS, REC 204, KITCHEN LI	1P20	I NIC
3	1020	 140 .
1920 MAIN LOBBY LIGHTS 540 204, KITCHEN LIGHTS + REC 1920 ASST. OFFICE RECEP RM. 204 HAND DRYER W.R. TVS BY FRONT DESK 1920 ASST. OFFICE RECEP RM 204 TVS 11	11 20	2
7 1P20 ASST. OFFICE RECEP RM. 204 HAND DRYER W.R. TVS BY FRONT DESK 9 1P20 ASST. OFFICE RECEP RM 204 TVS 11 1P20 ASST. OFFICE RECEP RM 204 TVS 13 1P20 ASST. OFFICE RECEP RM 204 CEILING FANS 15 1P20 COPIER RM 219 WATER FOUNTAIN RECEPTION 17 1P20 RECEPT. NURSERY 180 GENERAL RECEPTION 19 1P20 RECEPT. MUSIC CALL SYSTEM. UPPER LEVEL CLOCKTION 21 1P20 COPIER SPARETION 23 1P20 MICROWAVE RM. 219 T500 FRONT LOBBY DESK RECEDAL ALTERNATE 1	1 12/0	4
7 1P20 DRYER W.R. TVS BY FRONT DESK 9 1P20 ASST. OFFICE RECEP RM 204 TVS 11 1P20 ASST. OFFICE RECEP RM 204 CEILING FANS 15 1P20 ASST. OFFICE RECEP RM 204 WATER FOUNTAIN RECEPTION 17 1P20 RECEPT. NURSERY 180 GENERAL RECEPTION 19 1P20 RECEPT. MUSIC CALL SYSTEM. UPPER LEVEL CLOCKTION 21 1P20 COPIER SPARETION TLOBBY DESK RECETAIN 23 1P20 MICROWAVE RM. 219 1500 ALTERNATE 1	1P20	6
11 1P20 ASST. OFFICE RECEP RM 204 TVS 13 1P20 ASST. OFFICE RECEP RM 204 CEILING FANS 15 1P20 COPIER RM 219 WATER FOUNTAIN RECEP 17 1P20 RECEPT. NURSERY 180 GENERAL RECEP 19 1P20 RECEPT. MUSIC CALL SYSTEM. UPPER LEVEL CLOCK 21 1P20 COPIER SPARE 23 1P20 MICROWAVE RM. 219 1500 FRONT LOBBY DESK RECE ALTERNATE 1	1P20	8
13 1P20 ASST. OFFICE RECEP RM 204 CEILING FANS 15 1P20 COPIER RM 219 WATER FOUNTAIN RECEP 17 1P20 RECEPT. NURSERY 180 GENERAL RECEP 19 1P20 RECEPT. MUSIC CALL SYSTEM. UPPER LEVEL CLOCK 21 1P20 COPIER SPARE 23 1P20 MICROWAVE RM. 219 1500 FRONT LOBBY DESK RECE ALTERNATE 1	1P20	10
15 1P20 COPIER RM 219 1000 WATER FOUNTAIN RECEPTED 17 1P20 RECEPT. NURSERY 180 GENERAL RECEPTED 19 1P20 RECEPT. MUSIC CALL SYSTEM. UPPER LEVEL CLOCKTED 21 1P20 COPIER SPARETED 23 1P20 MICROWAVE RM. 219 TRONT LOBBY DESK RECED	1P20	12
17 1P20 RECEPT. NURSERY 180 GENERAL RECEP 19 1P20 RECEPT. MUSIC CALL SYSTEM. UPPER LEVEL CLOCK 21 1P20 COPIER SPARE 23 1P20 MICROWAVE RM. 219 FRONT LOBBY DESK RECE ALTERNATE 1	1P20	14
17 1P20 RECEPT. NURSERY GENERAL RECEPT 19 1P20 RECEPT. MUSIC CALL SYSTEM. UPPER LEVEL CLOCK 21 1P20 COPIER SPARE 23 1P20 MICROWAVE RM. 219 FRONT LOBBY DESK RECEAL RECEPT	1P20	16
21 1P20 COPIER SPARE 23 1P20 MICROWAVE RM. 219 The state of the stat	1P20	18
23 1P20 MICROWAVE RM. 219 FRONT LOBBY DESK RECE ALTERNATE 1	1P20	20
23 1P20 MICROWAVE RM. 219 1500 ALTERNATE 1	1P20	22
OF ADDO COUNTERTOR RECEP DIA CAG	PS 1P20	24
25 1P20 COUNTERTOP RECEP RM. 219 1000 RECEPT IN COURTS	1P20	26
27 1P20 REFRIGERATOR RM. 219 CLOCKS IN COURTS	1P20	28
29 1P20 RECPT. FOR SECURITY RECEPT IN COURTS	1P20	30
31 1P20 SIMPLEX UNIT FRONT LOBBY DESK RECE ALTERNATE 1	1P20	32
33 1P20 COMPUTER REGISTER FRONT LOBBY DESK RECE ALTERNATE 1	1P20	34
35 1P20 CONTROL DESK PANEL FRONT LOBBY DESK RECE ALTERNATE 1	PS 1P20	36
37 1P20 ROOM 218 EXHAUST FANS IN COURT	3P30	38
39 1P20 LOW VOLTAGE GLASS TRANSFORMER 100	1	40
41 1P20 SPARE	1	42
	LTAGE (LN)	
TOTAL PHASE A: 1000 NEW RATING: EXISTING VO	DLTAGE (LL) PHASE	
TOTAL PHASE B: 2840 ENCLOSURE: NEWA T	WIRE	
DEMAND VA: 5520 FEEDER SIZE: EXISTING	VVIINE	<u>· </u> +
MAND AMPS: 15.32 LOCATION: TENNIS SHOP		_

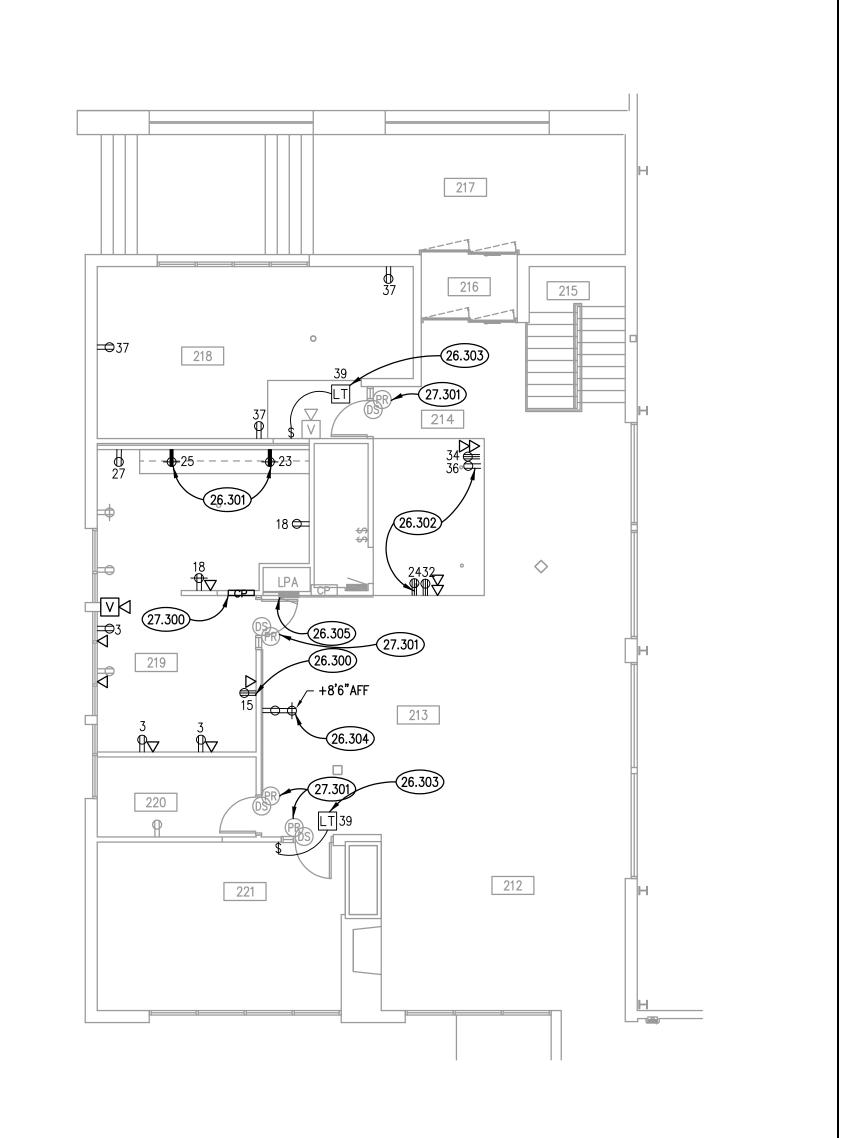

218

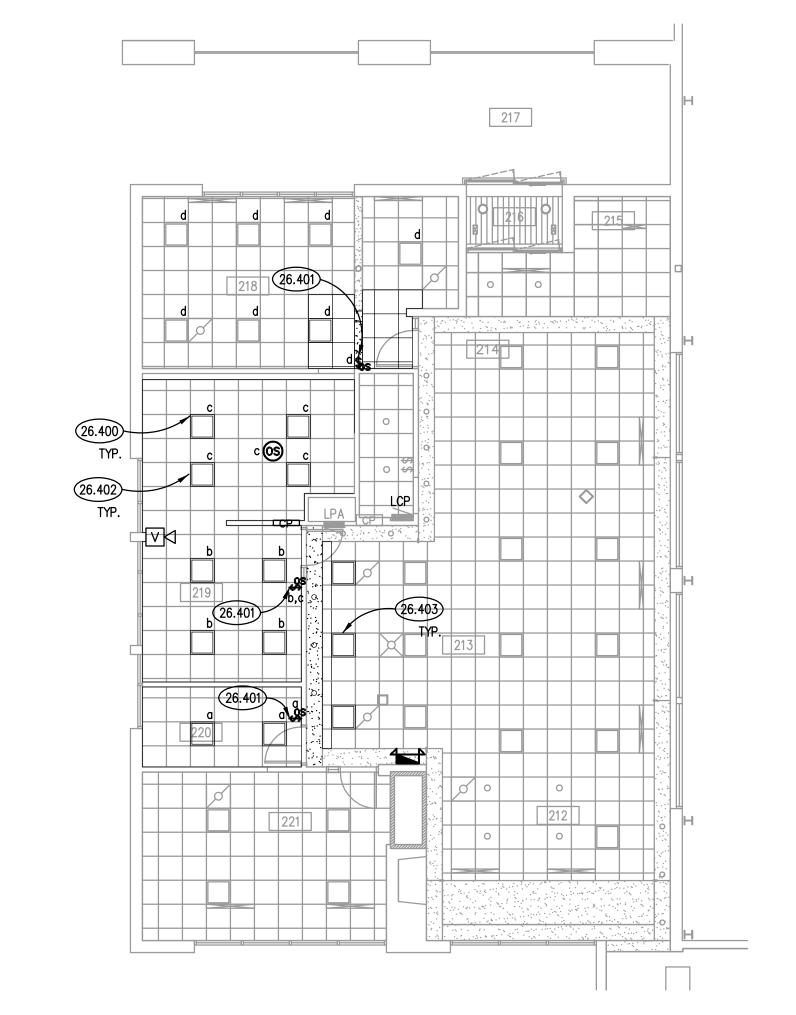

KEYNOTES

KEYNOTES ARE TYPICALLY NOT DUPLICATED WITHIN A GIVEN DETAIL. AN UN-KEYNOTED ITEM IN A DETAIL IS THE SAME AS A KEYNOTED ITEM HAVING THE SAME APPEARANCE WITHIN THE SAME DETAIL.

26.200 INTERCEPT AND EXTEND EXISTING CIRCUIT FOR TV TO NEW LOCATION IN THE SOFFIT. PROVIDE ALL MATERIALS

REQUIRED FOR DEMOLITION. 26.201 EXISTING LIGHTING FIXTURES ARE NOT TO BE DEMOLISHED. EXISTING LIGHTING FIXTURES ARE TO BE

26.302 COORDINATE REQUIRED RECEPTACLES AND DATA PORTS FOR NEW FRONT DESK. ALTERNATE 1 26.303 PROVIDE ELECTRICAL CONNECTION TO ELECTRONICALLY CONTROLLED SWITCHABLE GLASS. INSTALL LOW VOLTAGE TRANSFORMER, FURNISHED BY GLASS MANUFACTURER; LOCATE ABOVE ACCESSIBLE CEILING. PROVIDE ON/OFF

26.304 NEW LOCATION OF SOFFET TV RECEPTACLE. EXTEND EXISTING CIRCUIT TO NEW LOCATION. PROVIDE ALL

26.401 NEWLY INSTALLED OCCUPANCY LIGHT SWITCHES SHALL CONTROL THE LOCAL ROOM THEY ARE LOCATED WITHIN. 26.402 REUSE EXISTING LOCAL LIGHTING CIRCUIT FOR NEW LIGHTING. 26.403 LIGHTING IN THE COMMON AREA SHALL BE CONTROLLED VIA THE SAME LIGHTING CONTROLS AS PRE-DEMOLITION

TO NEW LOCATION. REUSE EXISTING BURGLAR ALARM SYSTEM.

27.300 NEW LOCATION FOR BURGLAR ALARM. INTERCEPT AND EXTEND EXISTING WIRING AND CONDUIT TO NEW LOCATION.

N	NEW DEVICE OR EQUIPMENT.
D	EXISTING ELECTRICAL OUTLET OR EQUIPMENT TO BE DEMOLISHED COMPLETE INCLUDING BRANCH CIRCUITRY TO SOURCE.
X	EXISTING ELECTRICAL OUTLET OR EQUIPMENT TO REMAIN. (CIRCUIT # = REROUTE EXISTING CIRCUIT TO NEW CIRCUIT NUMBER)

EXISTING ELECTRICAL OUTLET OR EQUIPMENT RELOCATED. (NEW LOCATION)

ROOM SCHEDULE

RM. NO.	ROOM NAME	RM. NO.	ROOM NAME
122	EXISTING CORRIDOR	136	EXISTING MEN'S TOILET ROOM
123	EXISTING CORRIDOR	137	EXISTING WOMEN'S TOILET ROOM
124	EXISTING STAIRS	138	EXISTING WOMEN'S SHOWER
125	EXISTING CORRIDOR	212	EXISTING LOUNGE
126	EXISTING ELECTRIC ROOM	213	EXISTING MERCHANDISE AREA
127	EXISTING WOMEN'S LOCKER ROOM	214	EXISTING LOBBY
128	EXISTING WOMEN'S LOCKER ROOM	215	EXISTING STAIRS
129	EXISTING LOUNGE	216	EXISTING ENTRY VESTIBULE
130	EXISTING WOMEN'S SAUNA	217	EXISTING OUTDOOR COVERED ENTRY
131	EXISTING MEN'S SAUNA	218	OFFICE
132	EXISTING MEN'S LOCKER ROOM	219	OFFICE AND BREAK ROOM
133	EXISTING MEN'S LOCKER ROOM	220	MERCHANDISE CLOSET

UPPER LEVEL POWER PLAN
SCALE: 1/8" = 1'-0"

UPPER LEVEL LIGHTING PLAN

SCALE: 1/8" = 1'-0"

KEY PLAN

JOB NO. 23-310-1501 CHECKED APPROVED SHEET TITLE ELECTRICAL PLANS &

UPPER LEVEL POWER DEMOLITION PLAN SCALE: 1/8" = 1'-0" UPPER LEVEL LIGHTING DEMOLITION PLAN

212

NOTE: SCALES DEPICTED ON THIS DRAWING ARE NOT CORRECT UNLESS PLOTTED SHEET SIZE IS 30 X 42 INCHES.

REMOVED, AND REINSTALLED AS POSSIBLE.

26.300 PROVIDE ALL MATERIALS REQUIRED FOR NEW COPIER. 26.301 PROVIDE GFCI COUNTERTOP OUTLETS IN NEW PANTRY AREA.

TOGGLE SWITCH GANGED WITH ROOM LIGHTING SWITCH.

MATERIALS REQUIRED FOR INSTALLATION. 26.305 ALL CIRCUITS THIS SHEET SHALL BE FED FROM THE EXISTING LPA PANEL.

26.400 NEW LIGHTING FIXTURES IN THE REMODELED AREAS SHALL BE REUSED FROM EXISTING MODIFIED CEILING LAYOUTS. CLEAN REUSED FIXTURES, AND PROVIDE NEW FROM EXISTING OWNERS STOCK

27.200 BURGLAR ALARM IS LOCATED IN WALL THAT IS TO BE DEMOLISHED. INTERCEPT AND EXTEND EXISTING WIRING

27.301 PROVIDE ALL MATERIALS REQUIRED FOR NEW PROXIMITY CARD READER.

ELECTRICAL DEMOLITION NOTATION

N	NEW DEVICE OR EQUIPMENT.
D	EXISTING ELECTRICAL OUTLET OR EQUIPMENT TO BE DEMOLISHED COMPLETE INCLUDING BRANCH CIRCUITRY TO SOURCE.
X	EXISTING ELECTRICAL OUTLET OR EQUIPMENT TO REMAIN. (CIRCUIT # = REROUTE EXISTING CIRCUIT TO NEW CIRCUIT NUMBE
·	EVICTING ELECTRICAL OUTLET OR FOLIDAENT RELOCATER

EXISTING ELECTRICAL OUTLET OR EQUIPMENT TO BE REMOVED & RELOCATED(OLD LOCATION).

133 EXISTING MEN'S LOCKER ROOM 134 EXISTING MECHANICAL ROOM 135 EXISTING MEN'S SHOWER 220 MERCHANDISE CLOSET
221 EXISTING OFFICE

MOIL

S

CENTER FRONT

TENNIS

SHEET NUMBER

E300